




1 FOUNDATION PLAN
S-1 SCALE: 1:125MTS

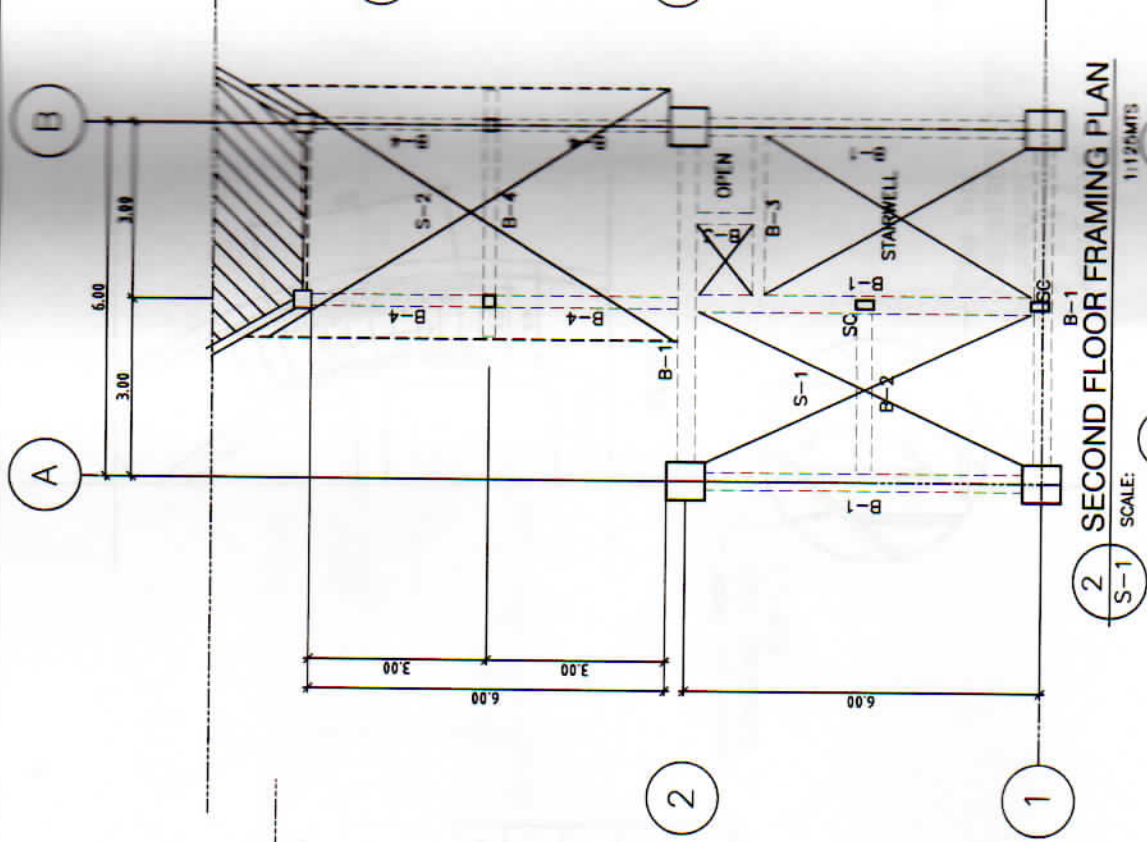

2 SECOND FLOOR FRAMING PLAN
S-1 SCALE: 1:125MTS

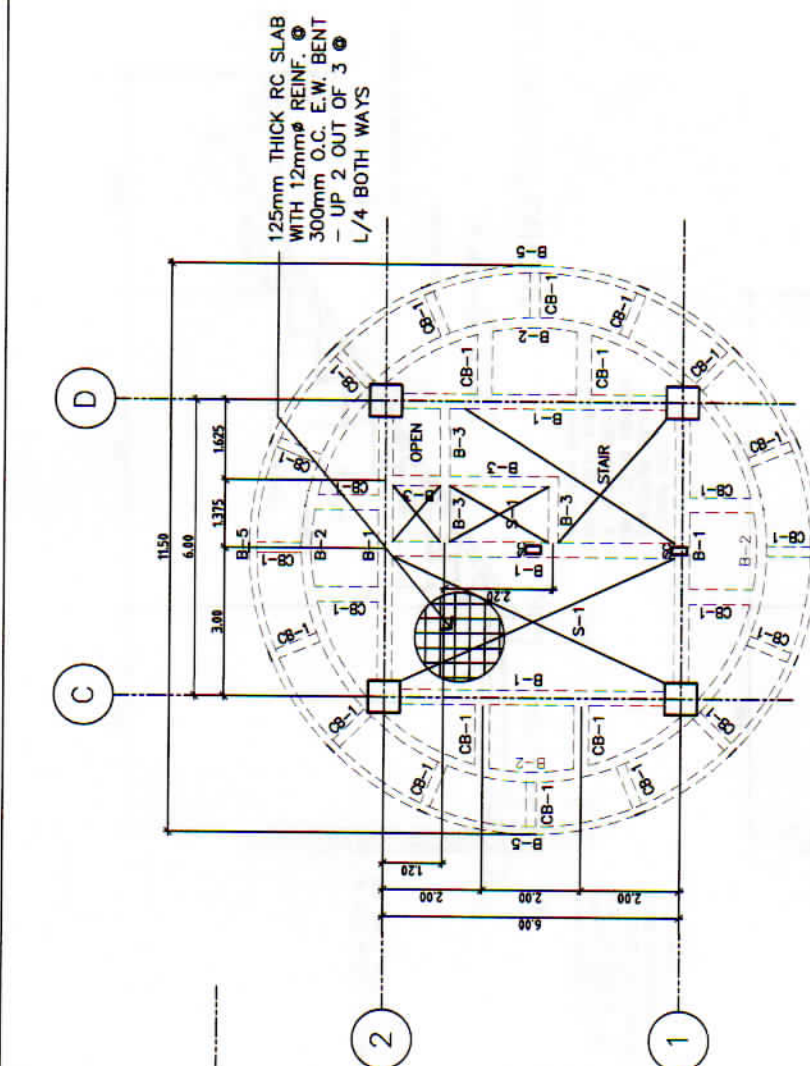

4 FIFTH FLOOR FRAMING PLAN
S-1 SCALE: 1:150MTS

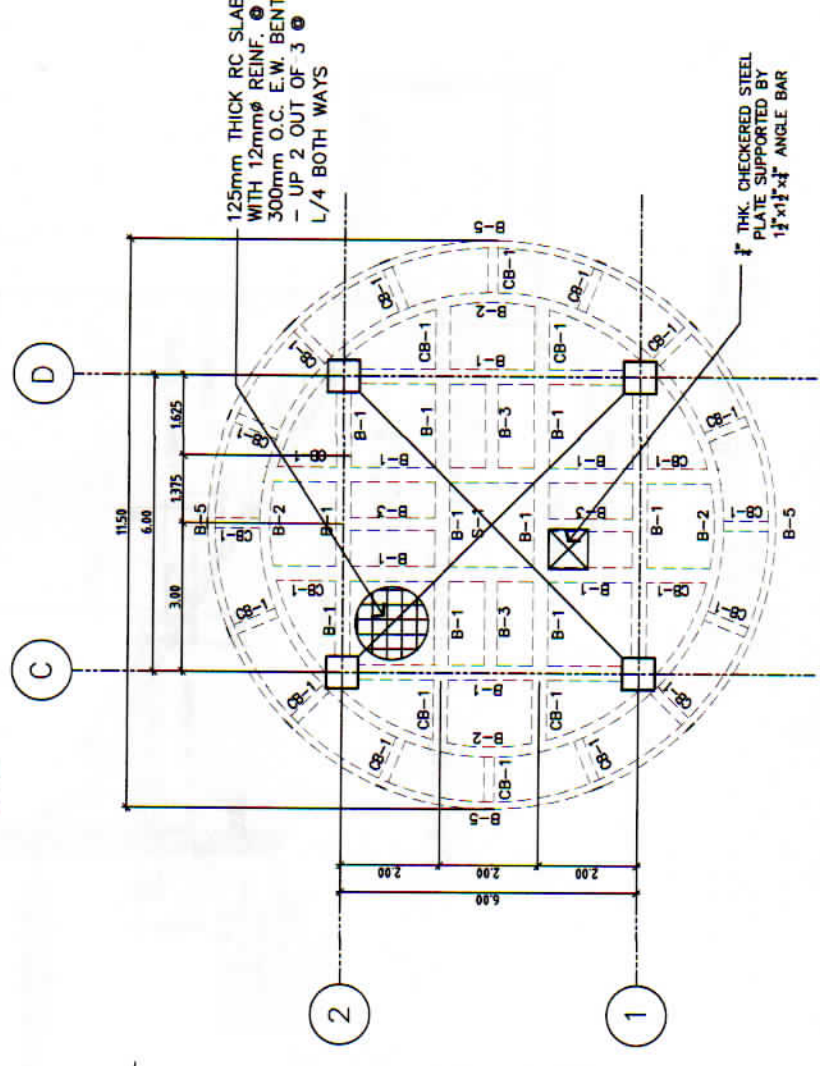

5 ROOF DECK FRAMING PLAN
S-1 SCALE: 1:150MTS

SCHEDULE OF SLAB :

MARK	SHORT DIRECTION	LONG DIRECTION
S-1	125 mm THK. + FINISH SLAB WITH 12mm Ø BARS @ 300 mm O.C. BENT - UP 2 OUT OF 3 @ L/4 BOTHWAYS	125 mm THK. + FINISH SLAB WITH 12mm Ø BARS @ 300 mm O.C. BENT - UP 2 OUT OF 3 @ L/4 BOTHWAYS
S-2	100 mm THK. + FINISH SLAB WITH 10mm Ø BARS @ 250 mm O.C. TOP AND BOTTOM	100 mm THK. + FINISH SLAB WITH 10mm Ø BARS @ 250 mm O.C. TOP AND BOTTOM

	OWNER	ARCHITECT/ENGINEER	ENGINEER	PROJECT TITLE	SHEET CONTENT	REVISION	SHEET NO.	
	VICENTE B. MAZANO, Ph.D. ADMINISTRATOR		ENGR. ROMER M. DELAIGUI CIVIL ENGINEER	REHABILITATION/REPAIR OF BASCO AND TOWER BUILDING	FOUNDATION AND FRAMING PLAN	DRAWN BY: ANGJ CHECKED BY: RMP DATE:	S-1	
				LOCATION: BRGY. TUKON, BASCO, BATANES				